










REVISION

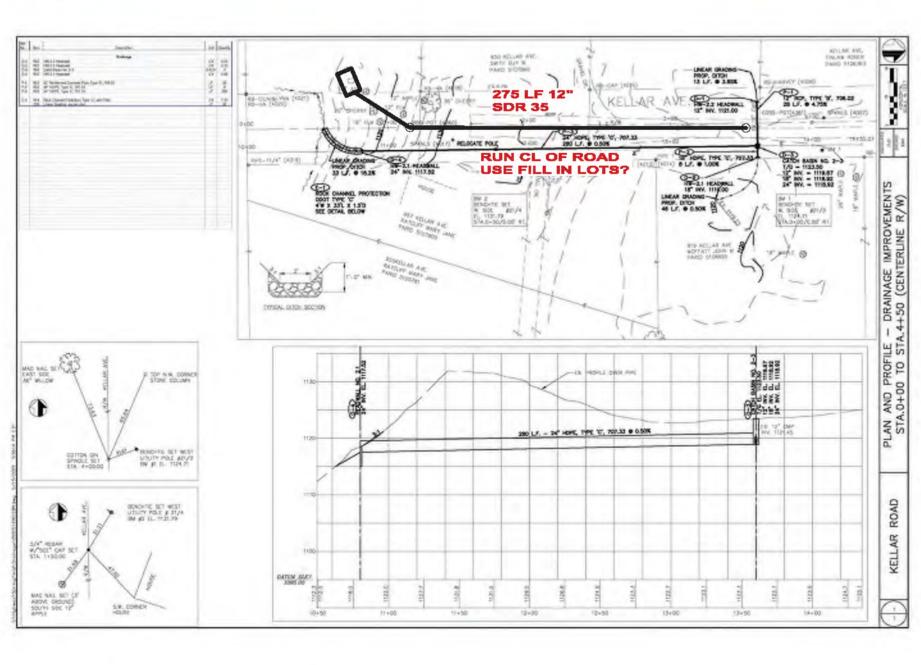


LEGEND

PROPOSED STORM SEWER "A"

EXISTING STORM SEWER


PROPOSED CATCH BASINPROPOSED STORM MANHOLE

FIELD PHOTO LOCATION

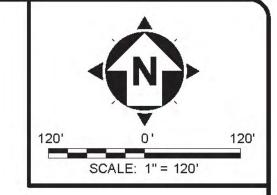

GENERAL NOTES

- THE RIGHT-OF-WAY AND PROPERTY LINE INFORMATION SHOWN ON THIS MAP HAS BEEN COMPILED FROM COUNTY GIS RECORDS AND IS NOT A PROPERTY SURVEY. RIGHT-OF-WAY AND PROPERTY LINES ARE SHOWN FOR GENERAL INTENT ONLY.
- 2. EXISTING TOPOGRAPHY SHOWN WAS OBTAINED FROM SUMMIT COUNTY GIS, AND WAS NOT OBTAINED FROM A FIELD GROUND SURVEY. PROPOSED ELEVATIONS ARE APPROXIMATE AND USED FOR PLANNING AND CONSTRUCTABILITY PURPOSES.
- 3. WETLAND AND STREAM INFORMATION SHOWN WAS OBTAINED FROM THE NATIONAL WETLAND INVENTORY MAPS AND PRELIMINARY WETLAND DETERMINATIONS DURING SITE VISITS CONDUCTED BY CT CONSULTANTS, INC BETWEEN NOVEMBER 2023 TO FEBRUARY 2024.
- 4. EXISTING UNDERGROUND UTILITIES WERE OBTAINED FROM VARIOUS SOURCES INCLUDING, BUT NOT LIMITED TO, FIELD OBSERVATIONS (E.G. ABOVE GROUND FEATURES) AND RECORDS MADE AVAILABLE (E.G. ORIGINAL CONSTRUCTION PLANS, AS-BUILT DRAWINGS, DISTRIBUTION AND SERVICE MAPS, GIS DATABASES, AERIAL PHOTOGRAPHY) TO CREATE A COMPOSITE DRAWING OF EXISTING CONDITIONS. ALTHOUGH GRAPHICALLY SHOWN AS ACCURATELY AS POSSIBLE FROM THE INFORMATION MADE AVAILABLE, THERE IS NO GUARANTEE OR WARRANTY, EXPRESSED OR IMPLIED, OF THE COMPLETENESS, CORRECTNESS OR ACCURACY OF SUCH UTILITIES IN THE AREA, EITHER IN SERVICE OR ABANDONED.

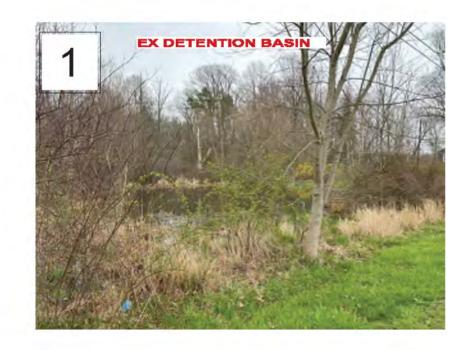













SUMMIT COUNTY/SPRINGFIELD LAKE NO.2 WATERSHED STUDY 15% CONCEPTUAL PLAN

SUMMIT COUNTY AKRON

2	ISSUED FOR: 1	5% CONCEPT
•	ISSUE DATE:	7/25/2024
IO.2	SCALE:	AS SHOWN
	DESIGNED BY:	JK
	DRAWN BY:	JK
AKRON, OHIO	CHECKED BY:	MRD


CONCEPTUAL SITE PLAN #1 - KELLAR

П	PROJE	CT NO.
	220	741
	DISCI	PLINE
1	CIV	/IL
	SHEET NAME	
١	CP	-01
ı	SHEET	OF
1	2	8

your trusted advisor

consultants

architects planners

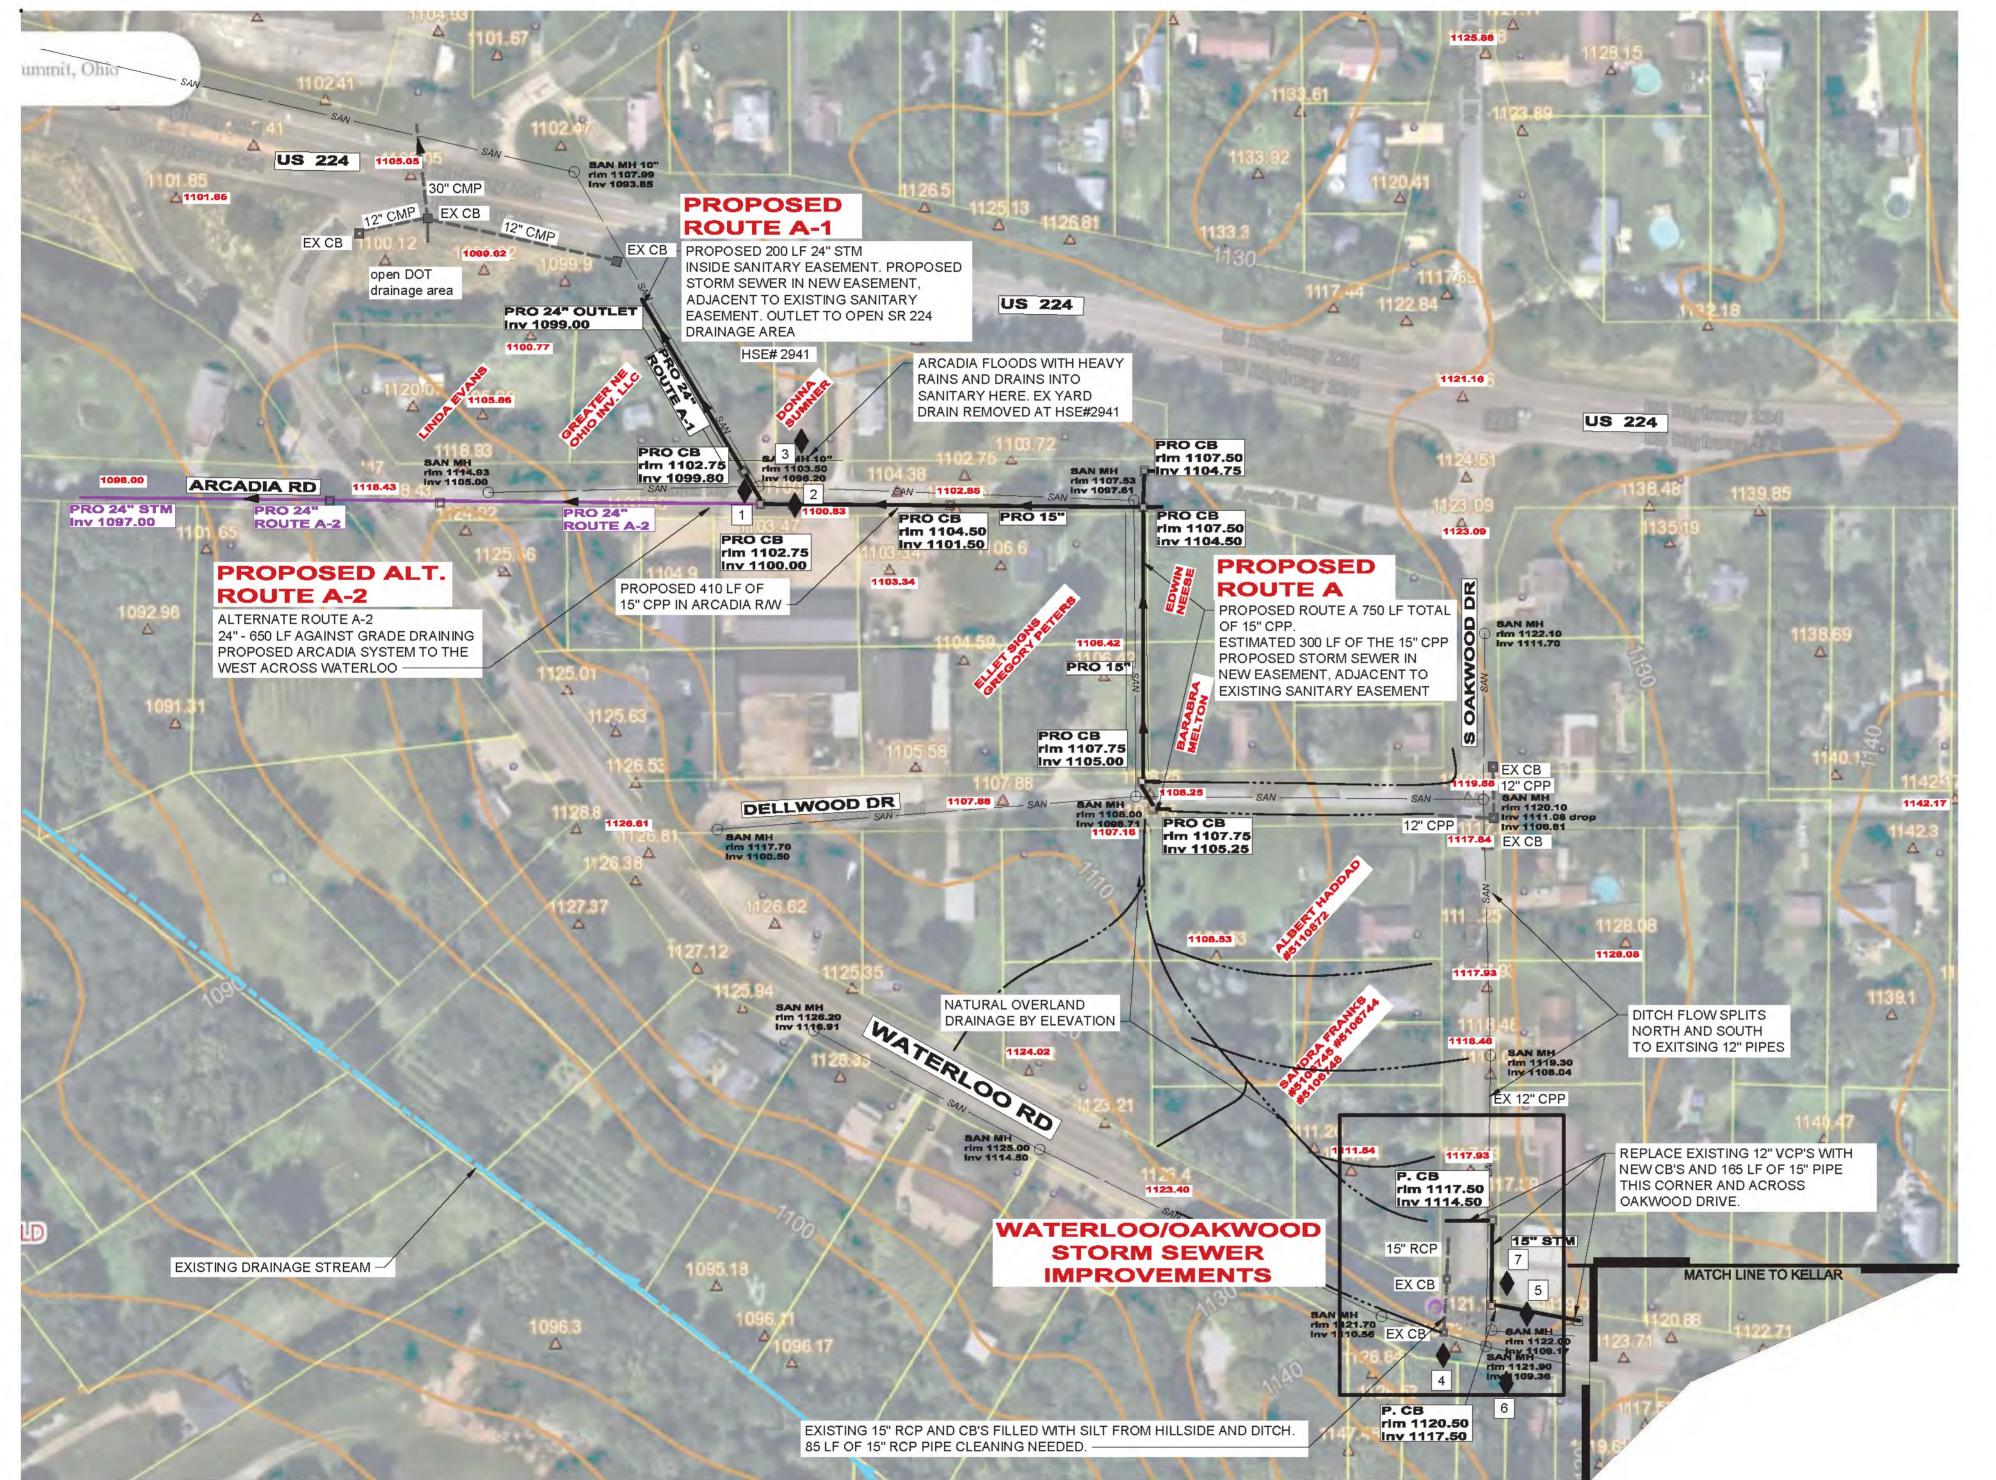



PROPOSED STORM SEWER "A"
PROPOSED STORM SEWER "A1"
PROPOSED ALT STORM SEWER "A2"
EXISTING STORM SEWER

☐ PROPOSED CATCH BASIN

PROPOSED STORM MANHOLE

FIELD PHOTO LOCATION











- 1. THE RIGHT-OF-WAY AND PROPERTY LINE INFORMATION SHOWN ON THIS MAP HAS BEEN COMPILED FROM COUNTY GIS RECORDS AND IS NOT A PROPERTY SURVEY. RIGHT-OF-WAY AND PROPERTY LINES ARE SHOWN FOR GENERAL INTENT ONLY.
- 2. EXISTING TOPOGRAPHY SHOWN WAS OBTAINED FROM SUMMIT COUNTY GIS, AND WAS NOT OBTAINED FROM A FIELD GROUND SURVEY. PROPOSED ELEVATIONS ARE APPROXIMATE AND USED FOR PLANNING AND CONSTRUCTABILITY PURPOSES.
- 3. WETLAND AND STREAM INFORMATION SHOWN WAS OBTAINED FROM THE NATIONAL WETLAND INVENTORY MAPS AND PRELIMINARY WETLAND DETERMINATIONS DURING SITE VISITS CONDUCTED BY CT CONSULTANTS, INC BETWEEN NOVEMBER 2023 TO FEBRUARY 2024.
- 4. EXISTING UNDERGROUND UTILITIES WERE OBTAINED FROM VARIOUS SOURCES INCLUDING, BUT NOT LIMITED TO, FIELD OBSERVATIONS (E.G. ABOVE GROUND FEATURES) AND RECORDS MADE AVAILABLE (E.G. ORIGINAL CONSTRUCTION PLANS, AS-BUILT DRAWINGS, DISTRIBUTION AND SERVICE MAPS, GIS DATABASES, AERIAL PHOTOGRAPHY) TO CREATE A COMPOSITE DRAWING OF EXISTING CONDITIONS. ALTHOUGH GRAPHICALLY SHOWN AS ACCURATELY AS POSSIBLE FROM THE INFORMATION MADE AVAILABLE, THERE IS NO GUARANTEE OR WARRANTY, EXPRESSED OR IMPLIED, OF THE COMPLETENESS, CORRECTNESS OR ACCURACY OF SUCH UTILITIES IN THE AREA, EITHER IN SERVICE OR ABANDONED.







ISSUED FOR:	15% C

CHECKED BY:

ISSUED FOR: 15% CONCEPT

ISSUE DATE: 7/25/2024

SCALE: AS SHOWN

DESIGNED BY: JK


DRAWN BY: JK

CONCEPTUAL SITE PLAN #2 - ARCADIA

T	PROJE	ECT NO.
	220	741
	DISCI	PLINE
	CIV	VIL
		NAME
	CP	-02
	SHEET	OF
	3	8

<	2
JA	>
MIL	
Lille	
2	

		NO	REVISION	DATE
Lyous trusted advises				
your trusted advisor consultants	→engineers architects			
4	planners			

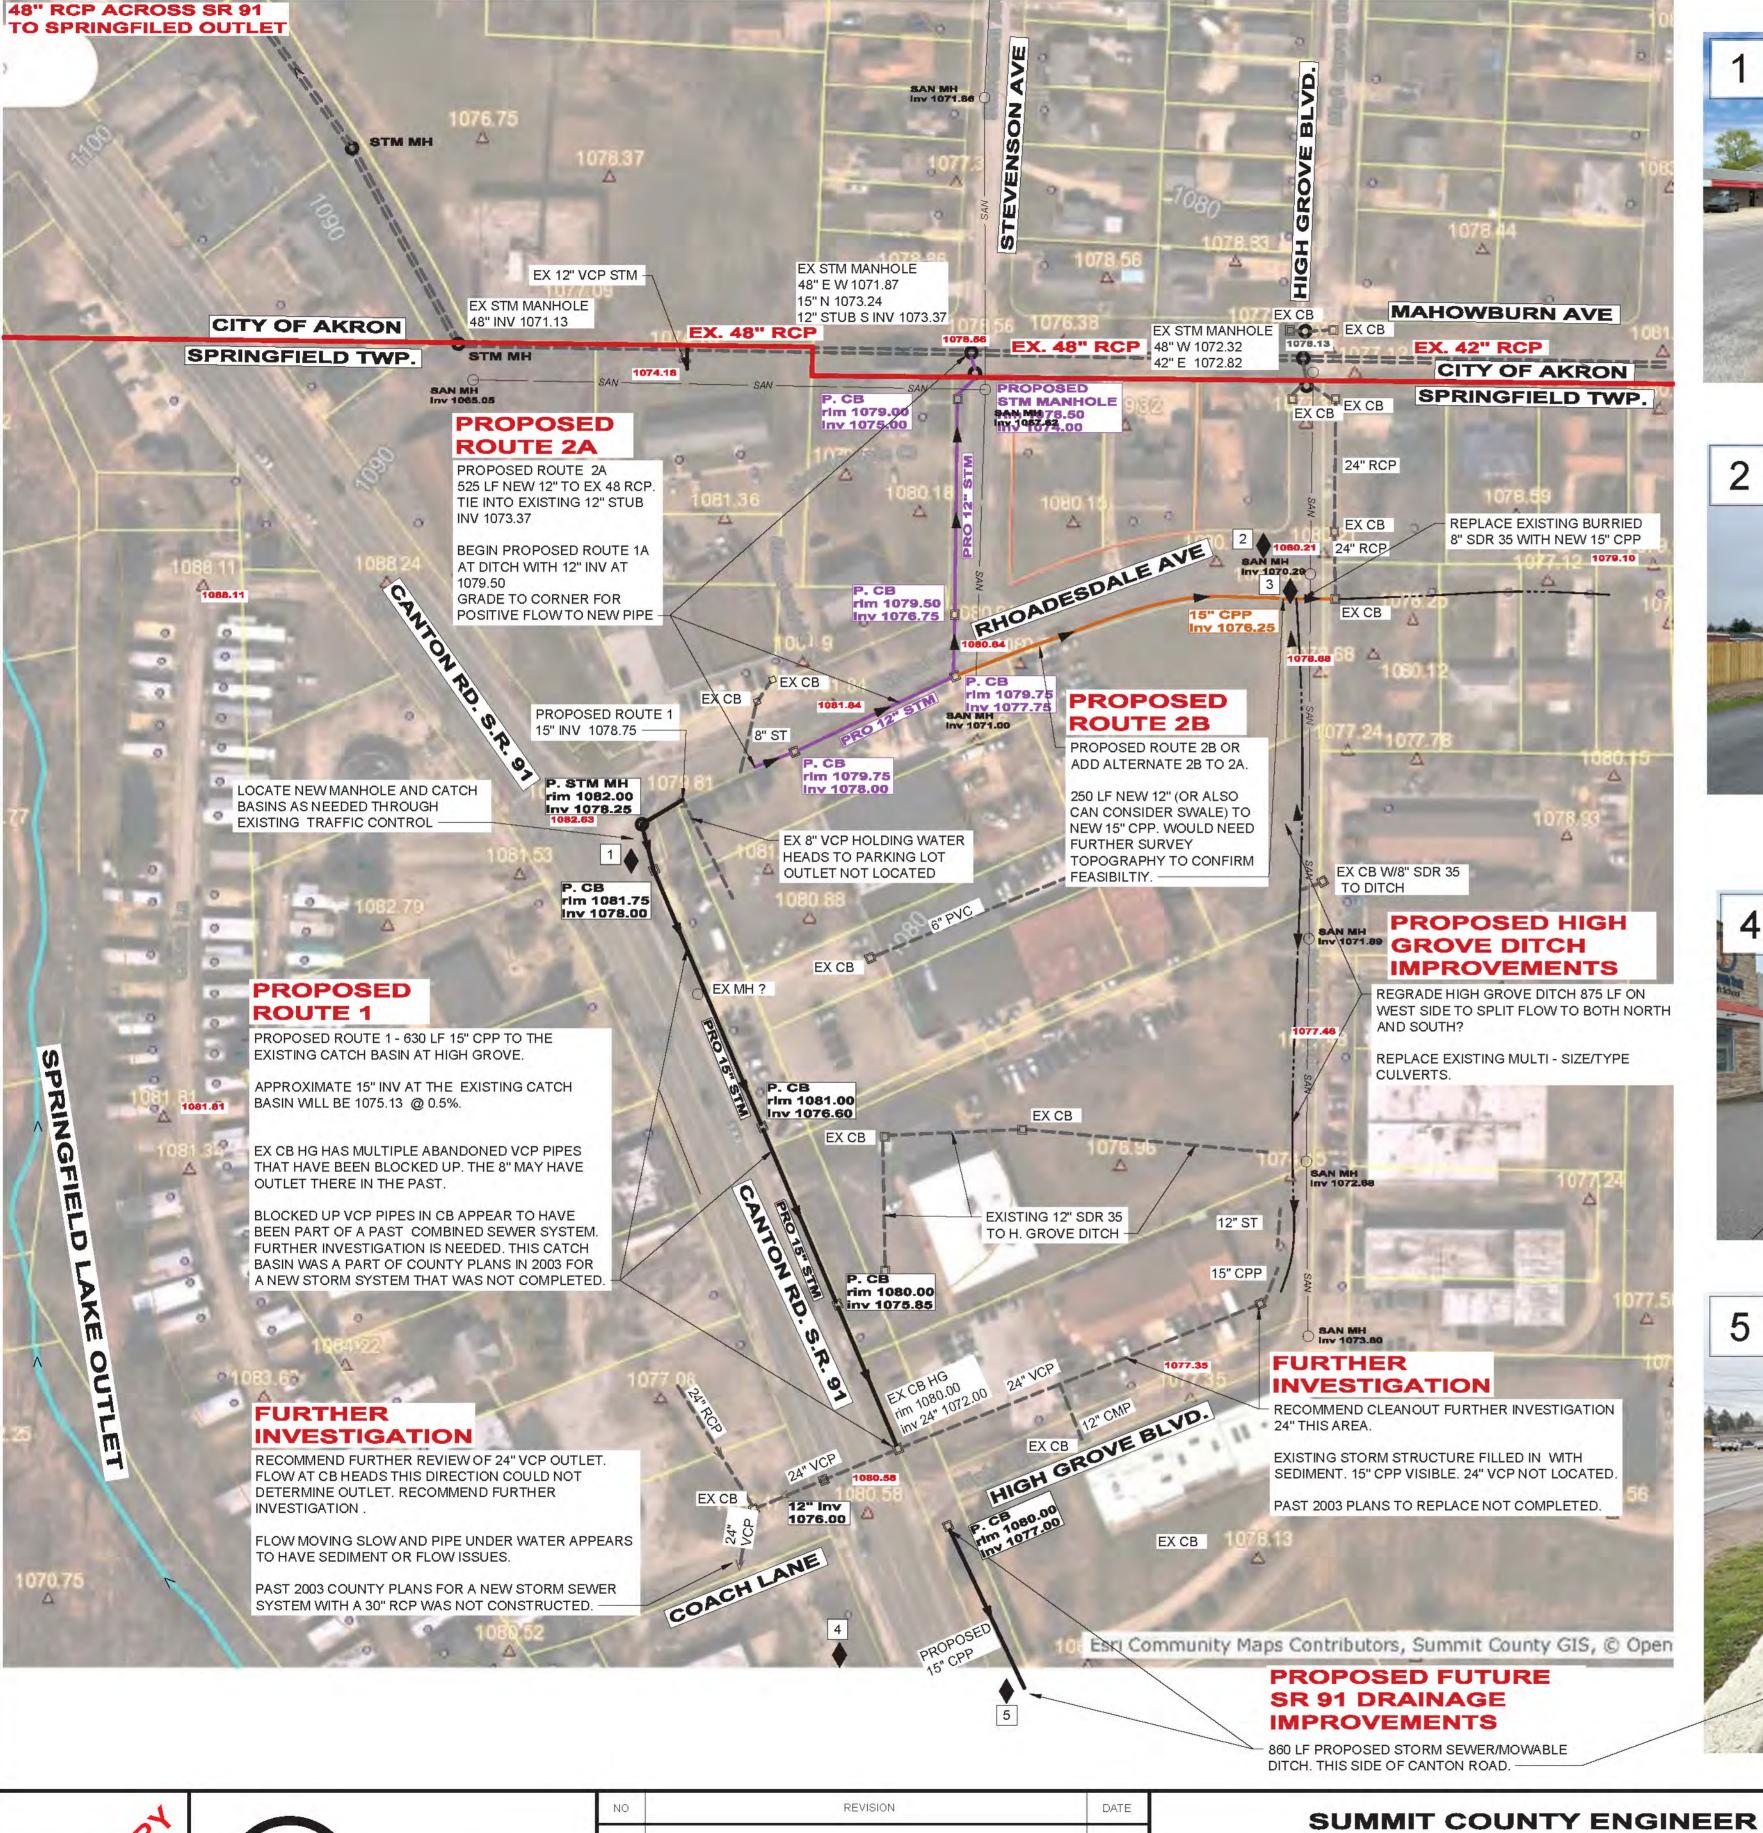







LEGEND

- PROPOSED STORM SEWER "1" PROPOSED STORM SEWER "2A"
- PROPOSED STORM SEWER "2B" EXISTING DITCH LINE
- PROPOSED CATCH BASIN PROPOSED STORM MANHOLE

EXISTING STORM SEWER

FIELD PHOTO LOCATION

GENERAL NOTES

1. THE RIGHT-OF-WAY AND PROPERTY LINE INFORMATION SHOWN ON THIS MAP HAS BEEN COMPILED FROM COUNTY GIS RECORDS AND IS NOT A PROPERTY SURVEY. RIGHT-OF-WAY AND PROPERTY LINES ARE SHOWN FOR GENERAL INTENT ONLY.

SCALE: 1" = 80 '

- 2. EXISTING TOPOGRAPHY SHOWN WAS OBTAINED FROM SUMMIT COUNTY GIS, AND WAS NOT OBTAINED FROM A FIELD GROUND SURVEY. PROPOSED ELEVATIONS ARE APPROXIMATE AND USED FOR PLANNING AND CONSTRUCTABILITY PURPOSES.
- 3. WETLAND AND STREAM INFORMATION SHOWN WAS OBTAINED FROM THE NATIONAL WETLAND INVENTORY MAPS AND PRELIMINARY WETLAND DETERMINATIONS DURING SITE VISITS CONDUCTED BY CT CONSULTANTS, INC BETWEEN NOVEMBER 2023 TO FEBRUARY 2024.
- EXISTING UNDERGROUND UTILITIES WERE OBTAINED FROM VARIOUS SOURCES INCLUDING, BUT NOT LIMITED TO, FIELD OBSERVATIONS (E.G. ABOVE GROUND FEATURES) AND RECORDS MADE AVAILABLE (E.G. ORIGINAL CONSTRUCTION PLANS AS-BUILT DRAWINGS, DISTRIBUTION AND SERVICE MAPS, GIS DATABASES, AERIAL PHOTOGRAPHY) TO CREATE A COMPOSITE DRAWING OF EXISTING CONDITIONS. ALTHOUGH GRAPHICALLY SHOWN AS ACCURATELY AS POSSIBLE FROM THE INFORMATION MADE AVAILABLE, THERE IS NO GUARANTEE OR WARRANTY, EXPRESSED OR IMPLIED, OF THE COMPLETENESS, CORRECTNESS OR ACCURACY OF SUCH UTILITIES IN THE AREA, EITHER IN SERVICE OR ABANDONED.









(SOUTH OF THE AERIAL LIMITS) (SOUTH OF THE AERIAL LIMITS)

SUMMIT COUNTY/SPRINGFIELD LAKE NO.2 WATERSHED STUDY 15% CONCEPTUAL PLAN

AKRON, OHIO SUMMIT COUNTY

ISSUED FOR:	15% CONCEPT
ISSUE DATE:	7/25/2024
SCALE:	AS SHOWN
DESIGNED BY:	JK
DRAWN BY:	JK
CHECKED BY:	MRD

CONCEPTUAL SITE PLAN #3 - RHOADSDALE

T	PROJE	ECT NO.	
-1	220	741	
	DISCIPLINE		
- 1	CIVIL		
	SHEET NAME		
-1	CP-03		
t	SHEET OF		
1	4	8)	

your trusted advisor

consultants

→engineers

architects

planners



ARE AT THE CORE OF THE OF THE PROBLEMS IN THIS AREA 15" CPP 180 LF EASEMENTS FROM (2) TWO PROPERTY OWNERS WILL BE NEEDED. rlm 1108.50 RELOCATE WATER Inv 1003.00 REPLACEMENT OF THE TWO 15" PIPES SHOULD BE CONSIDERED GAS SERVICES LIMITED COVER AND WOODED DEBRIS. GOOD UNNDER NEW 36" #6746521 PROPOSED 36"

STORM SEWER 24" TO TWIN 15" STM MCKENZIE AT THE STRUCTURE 940 LF 36" CPP STORM EXISTING CB 1 - RESIDENTS EXPLAIN THIS #6745560 SEWER @ min 7' DEEP CB BUBBLES UP DURING A HEAVY STORM VERIFY UTILITY CONFLICTS AND FLOODS SURROUNDING PROPERTIES CARPENTER EX STM STRUCTURE AND POSSIBLE VERTICAL RELOCATIONS. Inv 1005.00

EX. CB

EXISTING 24" RCP

ON TOP OF PIPE

#6841861

FROM CB 3

X. CB 3

18" CPP OVERFLOW TO DITCH 15" CMP PHOTOS

PROPERTY

TOP OF EXISTING PIPE NOT

BUBBLING UP. INSPECT ALL ELLIPTICAL PIPES ON MASSILLON

VISIBLE WATER PONDING AND

ROAD AREAS FOR BLOCKAGES -

SNODERLY

APPROXIMATE LOCATION OF OLD BRICE DITCH 8" TO 15" VCP SANITARY SEWER.

THIS SEWER IS ACTIVELY MOVING WATER

IN THIS AREA AND FURTHER FIELD

INVESTIGATION IS NEEEDED.

HOLDINGS

APPROX. 12" OF COVER

EXISTING 24" RCP AND CB'S

EXISTING 15" CMP TV 1103.68

12" ? VCP

BUBBLING U

FLOW INTO

15" CMP.

24" CPP W/CONC RAP

INK

EX. CB

12" CPP

rim 1118.74 Inv 1108.14

(COULD NOT BE LOCATED)

AREA 2 FURTHER INVESTIGATION IN THIS AREA IS NEEDED AS THE TERMINATION POINT OF THE 24" RCP COULD

WOODS RD SAN

NOT BE LOCATED. THIS AREA IS EXPERIENCING FLOODING AND HAS STANDING WATER. EASEMENT ACQUISITION WILL BE REQUIRED. THE 18" CPP AND 15" CMP SHOULD BE REPLACED

WITH A NEW PIPES. FLOW TO THIS AREA FROM MASSILLON ROAD NEEDS TO BE REDUCED. THE NEW PIPES LOCATED AN SIZED BASED ON THE 24" RCP OUTLET PIPE.

EX 18" CPP PIPE USED FOR CB CITY OF AKRON

SPRINGFIELD TWP.

AREA 3 AREA 3 IS A COLLECTION OF MULTIPLE SIZED STORM PIPES THAT ARE NOT WORKING TOGETHER. EASEMENT ACQUISITION WILL BE REQUIRED.

INCOMING FLOW FROM MASSILLON ROAD SHOULD BE REMOVED FROM THIS AREA AS MUCH AS POSSIBLE UNTIL IMPROVEMENTS TO AREAS 1 AND 2 AREA COMPLETE. IMPROVEMENTS TO THIS AREA WILL REQUIRE MANY MULTIPLE EASEMENTS.

OLD PLANS SHOW A 8" TO 15" VCP SANITARY LINE FRAVELING THROUGH THIS AREA. THIS OLD VCP LINE APPEARS TO BE AN ACTIVE PART OF THE CURRENT STORM SYSTEM WITH AN EXISTING 10" VCP TAKING STORM FLOW THROUGH A HOLE AT THE TOP OF THE PIPE AND TRAVELING TO EX CB3 WHERE ITE BUBBLES BACK UP. FURTHER INVESTIGATION IS NEEDED.

APPROXIMATELY 1000 LF OF BRICE DITCH REQUIRED CLEARING OF BRUSH AND DEBRIES TO THE SOUTH OF THE MANDRIN PROPERTY. SEE UPPER BRICE DITCH PHOTO THIS SHEET.



12" SAN GAS

AREA 1 PHOTOS



CONNECTION TO EXISTING

TBD APPROX. 36" inv 1103.00

OAKES DR

CITY OF AKRON

PROPOSED 36"

STORM SEWER

BRICK SEWER. VERIFY UTILITY

CONFLICTS AND POSSIBLE

ELLIPTICAL PIPE WITH NEW

RONALD RD

15" CMP

12" CMP

VERTICAL RELOCATIONS.

CONNECT TO EXISTING

STORM STRUCTURE.

APPROX. 1117.50 rim

36" -1110.50 inv

EX. CB 12" CMP

EX. CB 940 LF 36" CPP STORM SEWER

SPRINGFIELD TWP.

42" BRICK STORM SEWER

8" WATER CONFLICT?

EX. CB 3

34" X 53" STM

EX. CB

29"X45" STM

DATE

16" WATER

rim 1111.50

15" inv 1109.00


EX. CB


SAN MH 15" rim 1117.97 inv 1103.42

rlm 1116.00





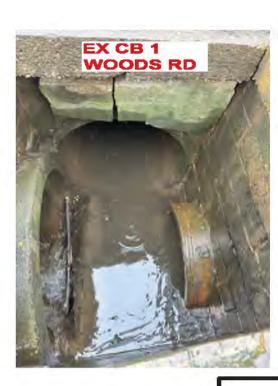

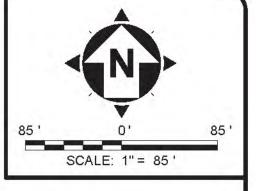


AREA 2 PHOTOS







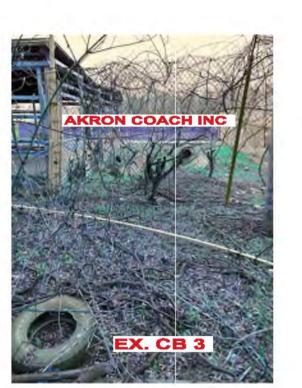

LEGEND

PROPOSED 36" STORM SEWER

EXISTING STORM SEWER PROPOSED CATCH BASIN

PROPOSED STORM MANHOLE

GENERAL NOTES

- THE RIGHT-OF-WAY AND PROPERTY LINE INFORMATION SHOWN ON THIS MAP HAS BEEN COMPILED FROM COUNTY GIS RECORDS AND IS NOT A PROPERTY SURVEY. RIGHT-OF-WAY AND PROPERTY LINES ARE SHOWN FOR GENERAL INTENT ONLY.
- EXISTING TOPOGRAPHY SHOWN WAS OBTAINED FROM SUMMIT COUNTY GIS, AND WAS NOT OBTAINED FROM A FIELD GROUND SURVEY. PROPOSED ELEVATIONS ARE APPROXIMATE AND USED FOR PLANNING AND CONSTRUCTABILITY PURPOSES.
- WETLAND AND STREAM INFORMATION SHOWN WAS OBTAINED FROM THE NATIONAL WETLAND INVENTORY MAPS AND PRELIMINARY WETLAND DETERMINATIONS DURING SITE VISITS CONDUCTED BY CT CONSULTANTS, INC BETWEEN NOVEMBER 2023 TO FEBRUARY 2024.
- 4. EXISTING UNDERGROUND UTILITIES WERE OBTAINED FROM VARIOUS SOURCES INCLUDING, BUT NOT LIMITED TO, FIELD OBSERVATIONS (E.G. ABOVE GROUND FEATURES) AND RECORDS MADE AVAILABLE (E.G. ORIGINAL CONSTRUCTION PLANS, AS-BUILT DRAWINGS, DISTRIBUTION AND SERVICE MAPS, GIS DATABASES, AERIAL PHOTOGRAPHY) TO CREATE A COMPOSITE DRAWING OF EXISTING CONDITIONS. ALTHOUGH GRAPHICALLY SHOWN AS ACCURATELY AS POSSIBLE FROM THE INFORMATION MADE AVAILABLE, THERE IS NO GUARANTEE OR WARRANTY, EXPRESSED OR IMPLIED, OF THE COMPLETENESS, CORRECTNESS OR ACCURACY OF SUCH UTILITIES IN THE AREA, EITHER IN SERVICE OR ABANDONED.

AREA 3 PHOTOS












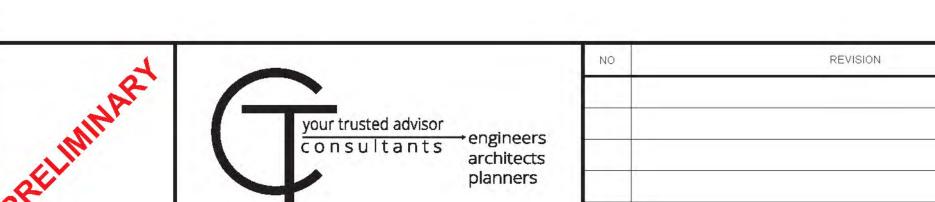

18" CPP

SHAFFER

EX CB 3 APPROX.

rim 1111.50

15" inv 1109.00 -

SUMMIT COUNTY ENGINEER

SUMMIT COUNTY/SPRINGFIELD LAKE NO.2 WATERSHED STUDY 15% CONCEPTUAL PLAN

AKRON, OHIO SUMMIT COUNTY

	ISSUED FOR:	15% CONCEPT
-0	ISSUE DATE:	7/25/2024
	SCALE:	AS SHOWN
1	DESIGNED BY:	JK
	DRAWN BY:	JK
1	CHECKED BY:	MRD

CONCEPTUAL SITE PLAN #4 - BRICE DITCH

	PROJE	CT NO.
	220	741
	DISCI	PLINE
1	CIV	/IL
	SHEET	NAME
1	CP-	-04
	SHEET	OF
	5	8
- 8		

